RESIDENTIAL RENOVATION -CONVERSION FROM TWO FAMILY TO THREE FAMILY

137 SUMMER ST, SOMERVILLE, MA 02143

SPECIAL PERMIT SET

<u>ZONING ANALYSIS</u> 137 SUMMER STREET SOMERVILLE, MA 02143 **ZONING DISTRICT: Resident District** ZONING SUB-DISTRICT: RB ARTICLE 8 - DIMENSIONAL REGULATIONS

ZONING ITEM	REQUIRED	existing	PROPOSED	relief required
IIN. LOT SIZE	7,500 9F	6,772 SF	NO CHANGE	EXISTING NON- CONFORMING
MIN. LOT AREA / DWELLING UNIT	1,500 SF (1-9 UNITS)	3,000 SF (2 UNITS)	4,600 SF (9 UNITS)	NO
MAX GROUND COVERAGE	50%	37.4%	39.1%	NO
MIN. LANDSCAPE AFIEA	25%	39.1%	30.2%	NO
FLOOR-AREA RATIO	1.0 (2)	0.470	0.698	NO
MAX, BUILDING HEIGHT (8TORIES)	3	2.5	3	NO
MAX, BUILDING HEIGHT (FEET)	40 FEET	26 FEET	34.5 FEET	NO
MIN. FRONT YARD	16 FEET	30.34 FEET	NO CHANGE	МО
M)N. SIDE YARD (139 Summer SI, Side)	8 - 10 FEGT ⁽⁷⁾	3.6 FEET	NO CHANGE	EXISTING NON- CONFORMING
MJN. SIDE YARD (183 Summer St. skle)	8 - 10 FEÉT ⁽⁶⁾	8.69 FEET	NO CHANGE	, NO
MIN. REAR YARD	20 FEET	16.6 FEET	NO CHANGE	EXISTING NON- CONFORMING
MIN. FRONTAGE	50 FE€T	60 FEET	NO GHANGE	NO
MIN. PERVIOUS AREA	35%	39.1%	39.4%	NO
OFF STREET PARKING SPACES PER TABLE E	1.5 PER UNIT	2	9	YES

NOTES:
2. Floor area ratio: See definition in Article 2 for floor area, floor area ratio; and Article 4 Section 4.4.1.4 which further limits floor area ratio requirement 7. Side Yard Selback is 6 feet for 2 - 2 1/2 Stories; 10 feet for 3 Stories

See sheets A0.01, A0.02, and A0.03 for Dimensional Regulation calculations

137 SUMMER ST. SOMERVILLE, MA - MULTI-FAMILY RESIDENCE

R-3 to R-2 MULTI-FAMILY RESIDENCE TYPE 5A CONSTRUCTION

EACH DWELLING UNIT IS SEPARATED BY A MINIMUM 1-HOUR RATED FLOOR AND CEILING ASSEMBLY, ENCLOSED COMMON STAIRS TO BE 1 HOUR RATED. ENTIRE BUILDING TO BE SPRINKLED.

CODE: MASS, NINTH EDITION, 2015 IBC WITH MA, AMENDMENTS


ZONING ANALYSIS: RB Resident District ARTICLE 8 - DIMENSIONAL REGULATIONS

GROSS SQUARE FOOTAGE - SEE SHEETS A0.01 & A0.02

INSULATION AND FENESTRATION REQUIREMENTS TO BE BY PRESCRIPTIVE COMPLIANCE, SEE SHEET A3.01

	SHEET LIST	
Sheet		
Number	Sheet Name	

CS	COVER SHEET
-A0.00	Plot Plan
-A0.01	GROSS AREA PLANS
-A0.02	NET AREA PLANS
-A0.03	SITE PLAN / CALCULATIONS
-A0.04	EXISTING PLANS AND ELEVATIONS
-A0.05	SUMMER SOLSTICE SHADOW STUDIES
A1.01	PROPOSED FLOOR PLANS
A1.02	PROPOSED FLOOR PLANS
A1.03	PROPOSED FLOOR PLANS
A2.01	PROPOSED ELEVATIONS
A2.02	PROPOSED ELEVATIONS
A3.01	BUILDING SECTIONS
A4.01	EXTERIOR AXON VIEWS

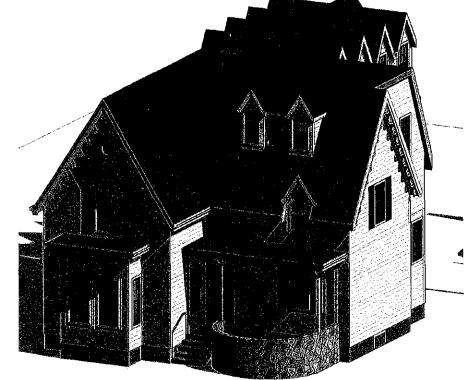

GENERAL NOTES

Project: Multi-Family Renovation 137 Summer St. Somerville, MA 02143

Property: Owner / Builder:

Stefanov Architects, 423 West Broadway, Ste.404, South Boston, MA 02127

Governing Code: Construction Type: Occupancy Use Group:

Architect:

780 CMR, Ninth Edition 2015 IBC with MA Amendments

Wood Frame, V-A Multi-Family - R2

1. Bidders shall be a General Contractor licensed to practice in the Commonwealth of Massachusetts. All subcontractors shall be similarly licensed, in their respective trades.

2. All work shall conform to state and local codes and the requirements of the local authorities having jurisdiction.

3. The Contractor(s) shall obtain and pay for all fees, taxes, and permits as required by the scope of work outlined in the construction documents.

4. General Contractor shall maintain General Liability and Workman's Compensation insurance during performance of the Work; and shall indemnify and hold harmless the Owner and Designer from all claims arising out of performance of same. The Owner shall carry property insurance covering all completed work and stored materials against fire, theft and storm damage and shall have glass breakage insurance for all installed glass units (or self insurance).

5. All work shall be performed in a workmanilke manner, by qualified mechanics specializing in the trades required. All materials and equipment employed shall comply with and be installed according to manufacturer's recommendations. All work shall be installed plumb, level and true.

6. The Contractor shall erect and maintain safeguards for the protection of the general public as required by the course of the work including: danger signs, lights, physical barriers, the covering of open excavations, etc. 7. All modifications requiring additional technical information shall be presented to the Owner and Architect before proceeding.

8. All claims for additional costs and Change Orders shall be submitted in a timely fashion, and in writing. The Owner's approval shall be obtained in writing, prior to proceeding with said work,

9. The Contractor shall remedy detects in the workmanship for a period of one year from Final Payment; and shall pass through to the Owner(s) all warranties on materials and equipment incorporated in the Work, as Issued by their suppliers and manufacturers.

10. Complete scope of work shall include but not be limited to: temporary equipment and power, hoisting, scatfolding, toilets, debris removal, etc.

11. The Owner shall furnish electricity and water required during the construction period at no cost to the Contractor.

12. Parking, material and equipment staging, and access to the site shall be directed per Owner approval only. 13. Contractor shall be responsible for all required demotition and debris removal. Remove and dispose of all debris legally off site. Cutting and patching of mechanical and electrical items shall be performed only by qualified mechanics of each respective trade.

14. Each Subcontractor shall be bound by the above conditions, to the General Contractor; and thereby in kind to the Owner.

ABBREVIATIONS

AT ACOUSTIC CEILING TILE ALUMINUM AGT ALUM. BD. BLDG. BOARD BUILDING BLOCKING CAST IRON BLK'G. C.I. CLG. CONT. CEILING CONTINUOUS COORD. EXIST. EXP. EXT. COORDINATE EXISTING EXPANSION FLASH'G. FRP POLYMER GENERAL CONTRACTOR G,C, GALV. GYP. INT. GALVANIZED GYPSUM INTERIOR INT, HORIZ, MANUF, MIN, MAX, M.O. O.C. P.T. JOINT MANUFACTURER MINIMUM MAXIMIM ON CENTER PRESSURE-PRESERVATIVE TREATED MAX. PWD. R.D. REQ. REQ'D R.C.P. PAINTED PLYWOOD ROOF DRAIN REQUIRED REQUIRED REFLECTED CEILING PLAN R.O. STL, T.O. TYP. V.B. V.P. ROUGH OPENING STEEL TOP OF TYPICAL VAPOR BARRIER VAPOR PERMEABLE VERT VIF WD. VERTICAL VERIFY IN THE FIELD WOOD

MULTIFAMILY RESIDENTIAL RENOVATION 137 SUMMER ST. SOMERVILLE, MA

STEFANOVARCHITECTS

423 WEST BROADWAY, SHITE 404 BOSTON, MA 02127

617,765,0543

INFO@STEFANOVARCH.COM



COVER SHEET

181204 2019-07-05 JMB DJS

---CS----

PROPOSED PLANT LIST Acer palmatum var. dissectum 'Crimson Queen' Japanese Maple Acer rubrum 'Armstrong' Armstrong Red Maple 2" cal. b&b Cedrus atlantica 'Glauca Fastigiata' Columnar Blue Atlas Cedar 6-7' ht. b&b CR Cornus 'Rutgan' Stellar Pink Dogwood 1.5-2" cal. b&b Shrubs & Vines: 3 gal. 3 gal. DZ Deutzia gracilis 'Duncan' Slender Deutzia FG Fothergilla gardenii DwarfWitch-Alder 3 gal. 5 gal. 5 gal. Hydrangea anomala petiolaris Climbing Hydrangea HO Hydrangea quercifolia Oakleaf Hydrangea Pots llex crenata 'Convexa' Boxleaf Japanese Holl Pots llex glabra 5 gal. 36" ht Inkberry Pots Ilex x meserveae 'Blue Princess' Blue Holly Pots Spiraea japonica 'Little Princess Japanese Spirea 3 gal. Pots Asarum canadense Wild Ginger Pots, 18" O.C. Athyrium niponicum 'Pictum Japanese Painted Fern 2 gal. Pots. 24" o.c. Ajuga reptans 'Burgundy Glow' Pots, 18" O.C. Bugleweed 4" pots 2 gal. I gal. Echinacea purpurea Pots, 24" o.c. Wild Geranium Pots, 18" o.c. Miscanthus sinensis 'Morning Light' Chinese Silver Grass Tiarella cordifolia 'Running Tapestry' Pots, 18" O.C Running Foamflower 2 gal. vm Vinca minor Creeping Myrtle Pots, 15" O.C. 4" pots

PLANTING NOTES

- All plant material shall be approved by the Landscape Architect prior to arrival on the site.
- All plant material shall conform to the guidelines established by "The American Standard for Nursery Stock", published by the can Association of Nurserymen, Inc.
- No substitution of plant species will be allowed without the approval of the Landscape Architect.
- The Contractor shall locate and verify all utility line locations prior to staking and report any conflicts to the Landscape Architect.
- All plants shall be staked out in their approximate location by the Contractor. The Contractor shall adjust the locations of these kes as required by the Landscape Architect to account for subsurface utilities, other field conditions and to achieve design intent. Final tions must be approved by the Landscape Architect prior to planting.
- No planting shall be installed before acceptance of rough grading of topsoil.
- The rootballs of trees shall be planted 3" above adjacent finished grade. Excavate holes no deeper than the rootball of trees. Holes hall be at least 3' greater in diameter than root ball. Backfill planting hole with 'planting mix'. All plants which settle out of plumb or below ned grade shall be immediately replanted.
- The rootballs of shrubs shall be planted 2" above adjacent finished grade. Excavate holes no deeper than the rootball of shrubs.
- All shrubs, groundcovers and perennials shall be planted in continuous planting beds. All beds shall be excavated 12" and the topso subsoil set aside for reuse. Remove all stone and debris from excavated soil. Backfill beds with 12" of planting mix' before planting rubs, perennials and groundcovers.
- 'Planting Mix' shall consist of 2 parts of topsoil saved from site excavations and 1 part compost. Thoroughly mix to create uniform lended mixture. If insufficient topsoil is available on the site, mix existing soil in a ratio of I part soil to I part compost. Remove all stones and debris larger than 2" from planting mix.
- . All beds as shown on the drawings shall be edged with a 4" trench neatly cut and backfilled with bark mulch. All beds shall be vered with no less than 2"depth settled bark mulch and no greater than 3" depth bark mulch.
- tion, at least twice within the first 24 hours



Wild Ginger



Ajuga reptans 'Burgundy Glow'



Sunrise' Tickseed








Nepeta x faassenii 'Blue Wonder' Catmint



Tiarella cordifolia 'Running Tabestry' Running Foamflower



Miscanthus sinensis 'Morning Light' Chinese Silver Grass

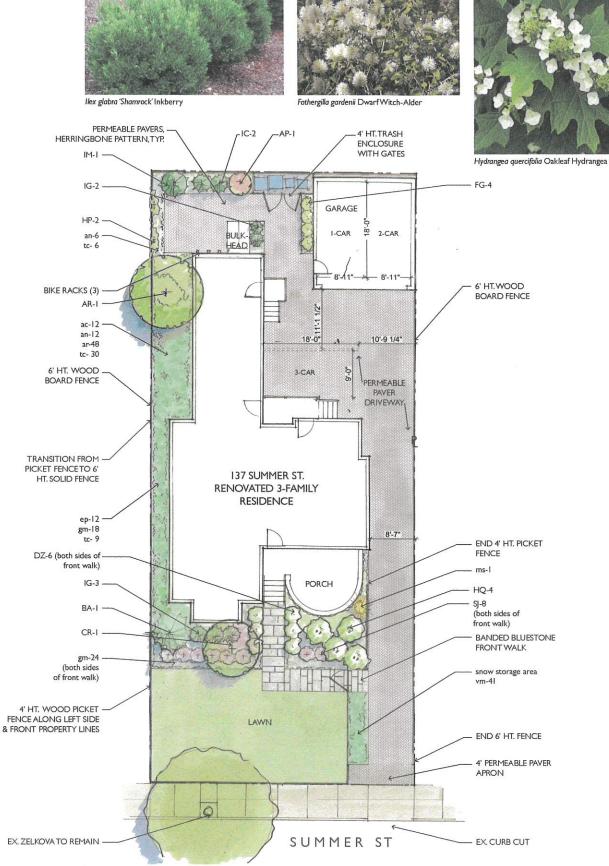





Spirea japonica 'Little Princess Japanese Spirea



llex x meserveae 'Blue Princess' Blue Holly



Duetzia gracilis 'Duncan' Slender Deutzia



Acer palmatum var. dissectum 'Crimson Queen' Japanese Maple



Cornus 'Rutgan' Stellar Pink Dogwood



6' Ht Wood Board Fence Along Sides & Rear



4' Ht Wood Picket Fence Along Front & Left Property Lines










ILLUSTRATIVE LANDSCAPE PLAN 137 SUMMER STREET SOMERVILLE, MA JULY 3, 2019

EXISTING:

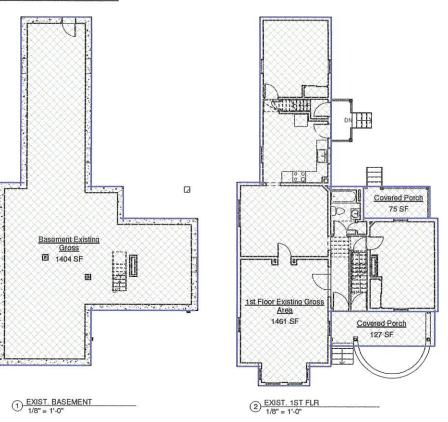

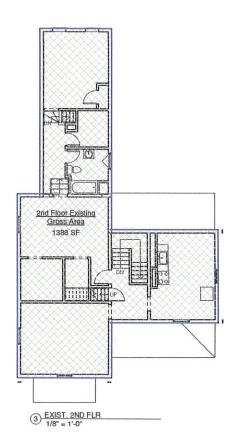

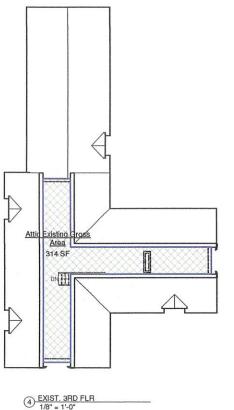

Name	Area
Basement Existing Gross	1404 SF
1st Floor Existing Gross Area	1461 SF
Covered Porch	127 SF
Covered Porch	75 SF
Existing Garage	410 SF
2nd Floor Existing Gross Area	1388 SF
Attic Existing Gross Area	314 SF
Grand total	5179 SF

2.2.57 Floor area, gross. The sum area of all floors or accessible levels of a building as measured to the perimeter of the exterior faces of the walls with no deduction for corridors, stairs, closets, thickness of walls, columns or other features. The gross floor area of an unenclosed area on a parcel, developed and used as a principal use, shall be the contiguous land area needed and used to support the activity(-ies) of said use.

MULTIFAMILY RESIDENTIAL RENOVATION 137 SUMMER ST. SOMERVILLE, MA

STEFANOVARCHITECTS

423 WEST BROADWAY, SUITE 404 BOSTON, MA 02127

617.765.0543

INFO@STEFANOVARCH.COM



Date

GROSS AREA PLANS


Project number	181204
Date	2019-07-05
Drawn by	JME
Checked by	DJS


-A0.01


1/8" = 1'-0"


PROPOSED:

5 BASEMENT 1/8" = 1'-0"

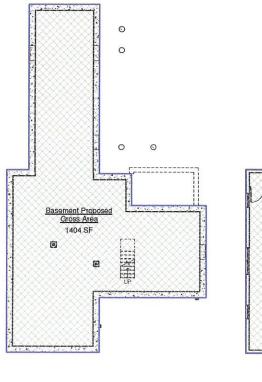

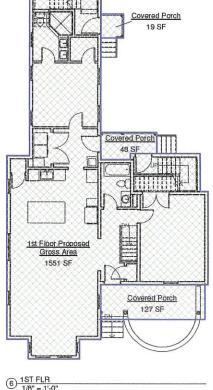

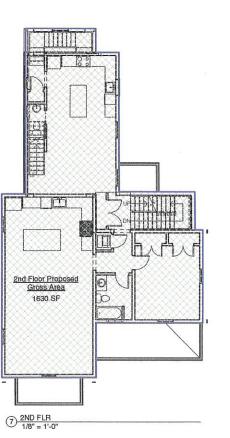

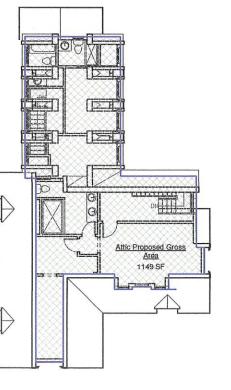

8 ATTIC 1/8" = 1'-0"

6339 SF (Proposed)	÷ 5179 SF (Existing) = 1.224
= 22.4% INCREASE	

Area Schedule (Proposed Gross Areas)

Basement Proposed Gross Area 1404 SF 1st Floor Proposed Gross Area 1551 SF

Garage
2nd Floor Proposed Gross Area 1630 SF
1149 SF

Attic Proposed Gross Area


GROSS AREA INCREASE:


Name


Covered Porch Covered Porch

Covered Porch

EXISTING:

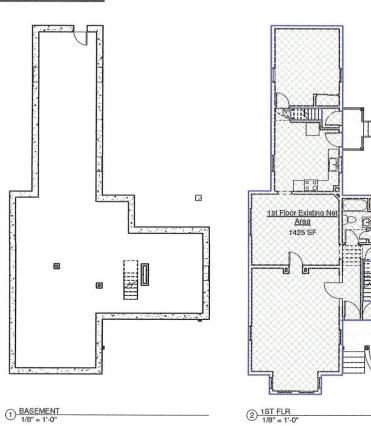

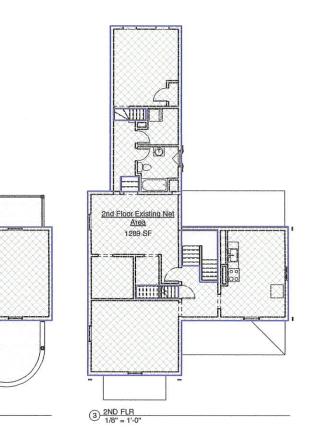

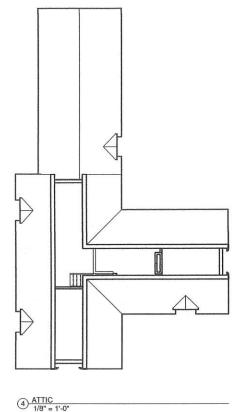

Area Schedule (I	Existing Net Area)

1st Floor Existing Net Area	1425 SF
2nd Floor Existing Net Area	1289 SF
Grand total	2714 SF

EXISTING FAR = 2714 / 5772 = 0.470

2.2.58 Floor area, net. The sum area of all floors or accessible levels of a building as measured to the perimeter of the exterior faces of the walls, including enclosed porches, but excluding areas used for accessory garage purposes, basement, and cellar, closet, and attic areas devoted exclusively to storage and mechanical uses accessory to the operation of the building, off-street loading facilities, malls, plazas, elevator shafts, escalators, stairways and stair landings, and those areas used for the storage, operation or maintenance of mechanical equipment such as air conditioning and heating apparatus.

2.2.59 Floor area ratio (FAR). In all zones except TOD and CCD, FAR is the ratio of the net floor area of a building to the total area of the lot it is located upon, except that portion of a structure used as an accessory use child care facility is exempted from the floor area ratio (FAR) calculation, and the allowable floor area of such structure shall be increased by an amount equal to the floor area of the child care facility up to a maximum of ten (10) percent, provided the requirements of M.G.L. Chapter 40A, Section 3 are also met.

MULTIFAMILY RESIDENTIAL RENOVATION 137 SUMMER ST. SOMERVILLE, MA

STEFANOVARCHITECTS


423 WEST BROADWAY, SUITE 404 BOSTON, MA 02127


617.765.0543


INFO@STEFANOVARCH.COM




PROPOSED:

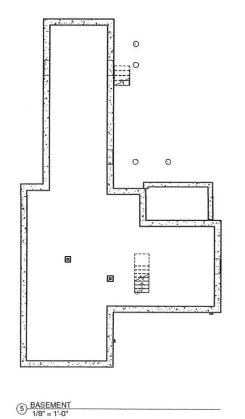

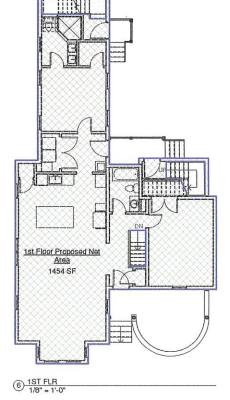

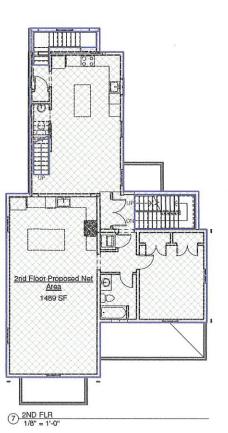

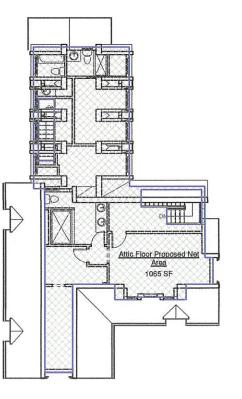

Area Schedule (Proposed	Net Area)
Name	Area
1st Floor Proposed Net Area	1454 SF
2nd Floor Proposed Net Area	1489 SF
Attic Floor Drangaged Not Area	100E CE

PROPOSED FAR = 4007 ÷ 5772 = 0.69

-	
25073110	
13/5-5-42/4	
120000	
1000	


NET AREA PLANS

181204 2019-07-05 Drawn by Checked by JMB DJS

-A0.02

1/8" = 1'-0"

Date

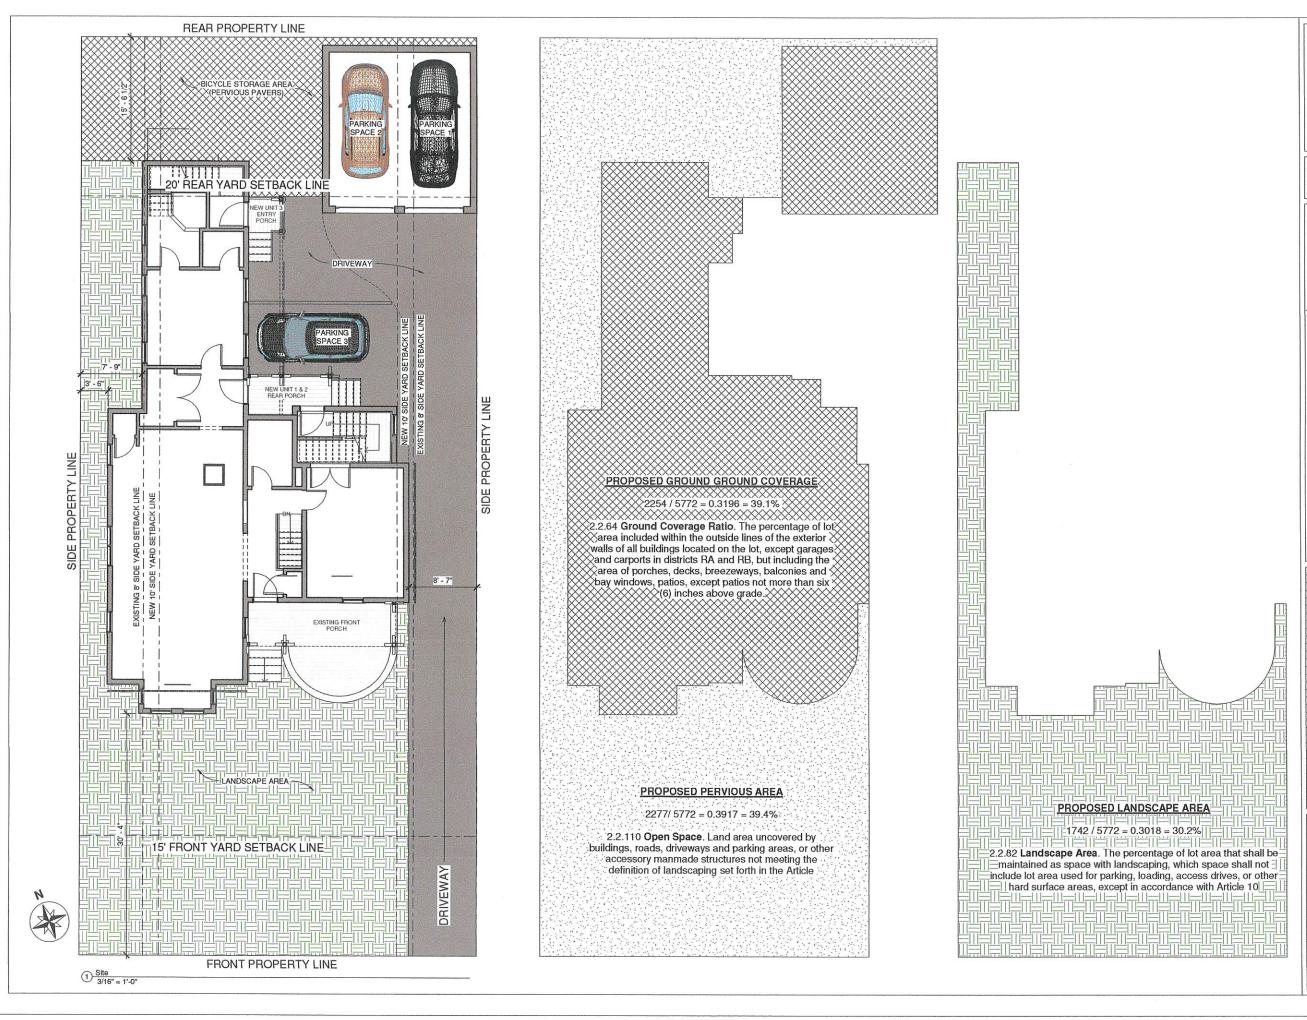

STEFANOVARCHITECTS

423 WEST BROADWAY, SUITE 404 BOSTON, MA 02127

617.765.0543

INFO@STEFANOVARCH.COM



No. Description Date

SITE PLAN / CALCULATIONS

 Project number
 181204


 Date
 2019-07-05

 Drawn by
 JMB

 Checked by
 DJS

-A0.03

3/16" = 1'

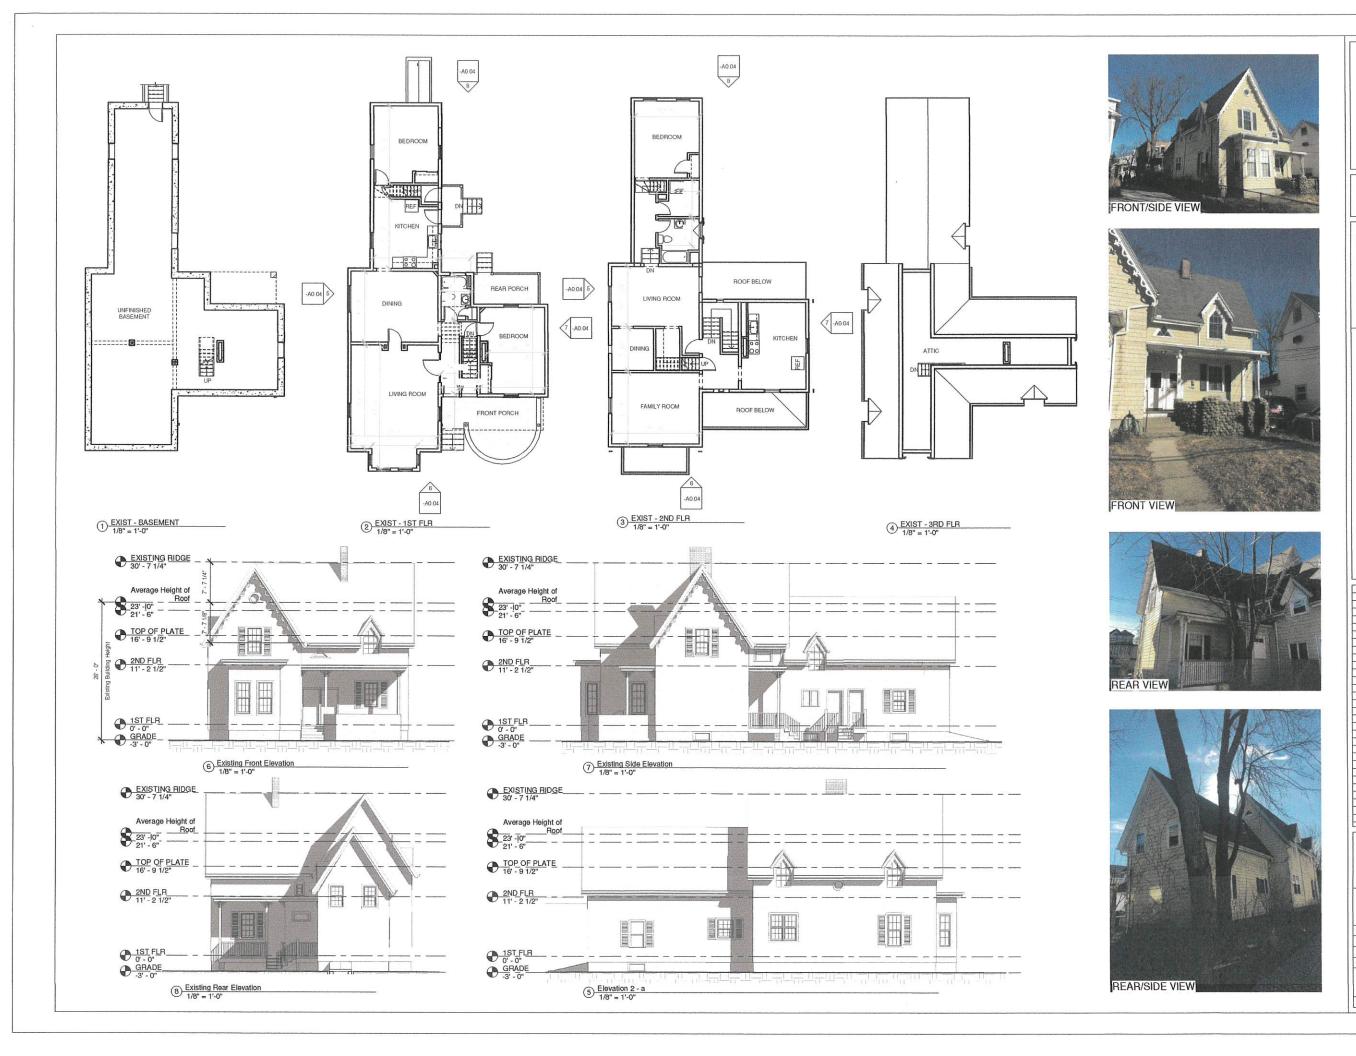

STEFANOVARCHITECTS

423 WEST BROADWAY, SUITE 404 BOSTON, MA 02127

617.765.0543 INFO@STEFANOVARCH.COM



lo. Description Date


EXISTING PLANS AND ELEVATIONS

Project number 181204
Date 2019-07-05
Drawn by JMB
Checked by DJS


J. O I


1/8" = 1'-0

EXISTING:

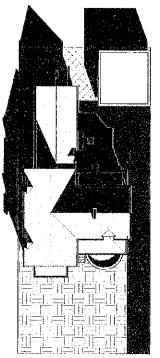


1/16" = 1'-0"

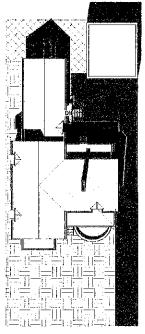


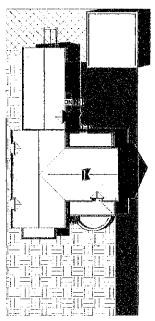

(3) EXISTING SHADOWS 12 PM

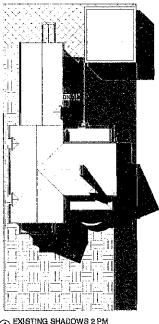

(4) EXISTING SHADOWS 2 PM

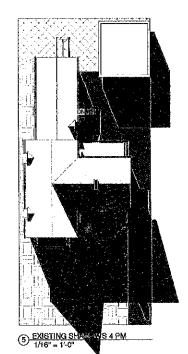

MULTIFAMILY RESIDENTIAL RENOVATION 137 SUMMER ST. SOMERVILLE, MA

STEFANOVARCHITECTS


423 WEST BROADWAY, SUITE 404 BOSTON, MA 02127

617.765.0543


INFO@STEFANOVARCH.COM




PROPOSED:

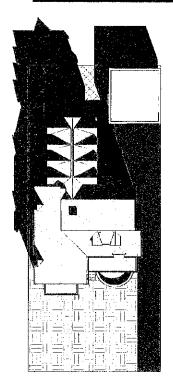


6 PROPOSED SHADOWS 8 AM

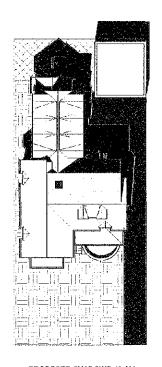


7 PROPOSED SHADOWS 10 AM

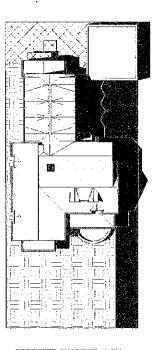

8 PROPOSED SHADOWS 12 PM 1/16" = 1'-0"

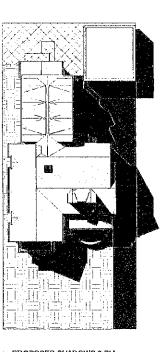

9 PROPOSED SHADOWS 2 PM

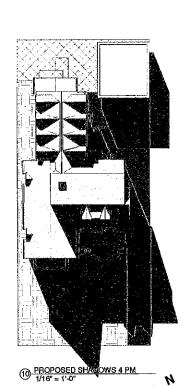



	·		
	· · · · · · · · · · · · · · · · · · ·	 	
		 	
			
1			
		 	
-			
			
		 	
	· · · · · · · · · · · · · · · · · · ·		
1			
1			
1			
1			
1			
├			
l e	TO IOD GENNALI		
ں ا	SUMMER SOLSTICE		
	SHADOW STUDIES		
	ロベレノリア うししほり	E.3	


181204 2019-07-05 JMB DJS

-A0.05

1/16" = 1'-0"

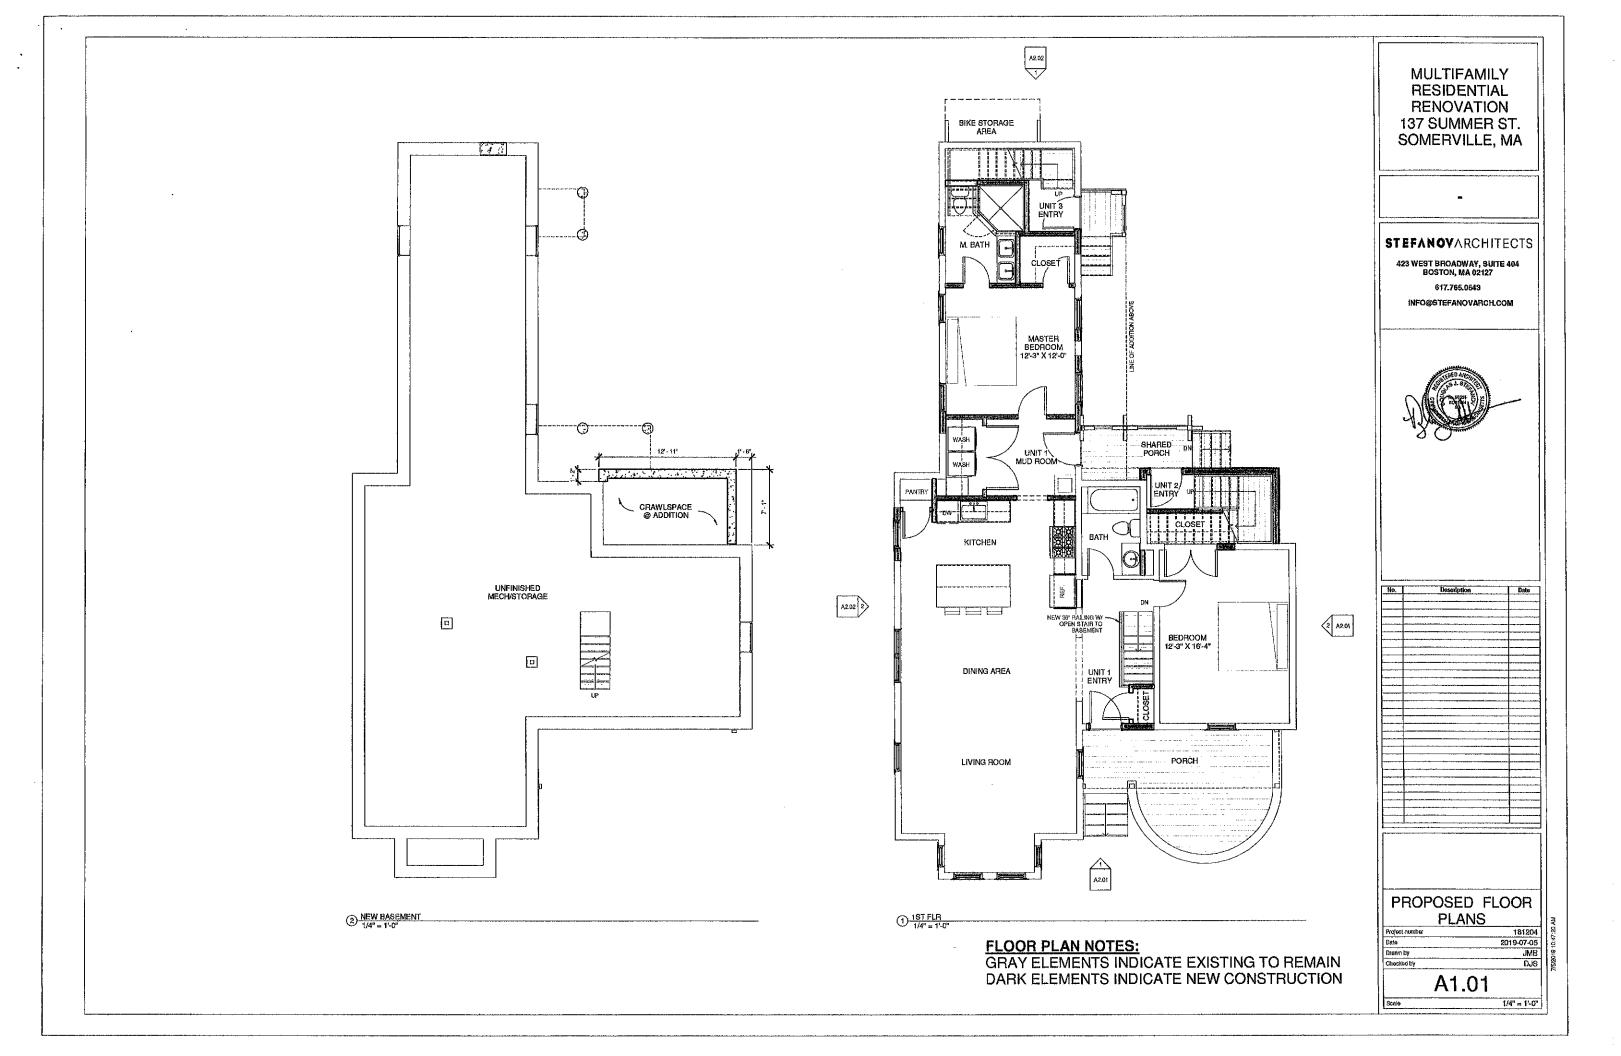

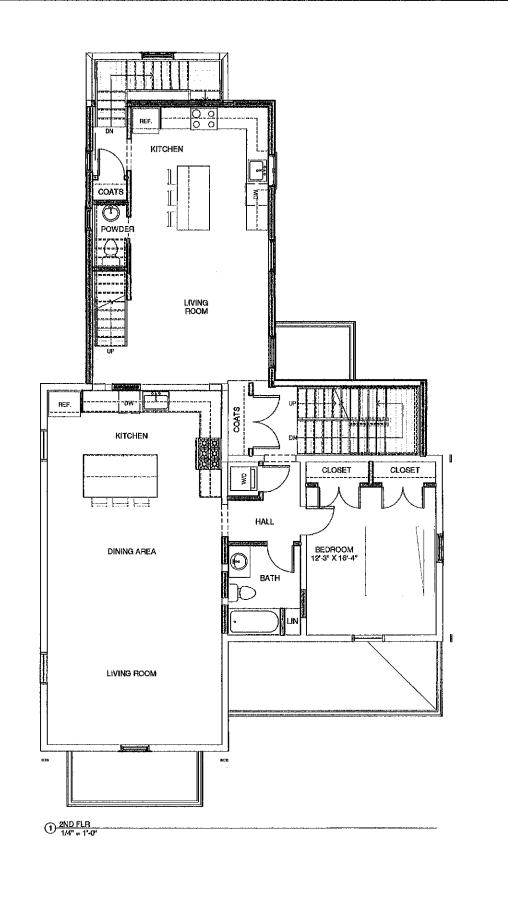

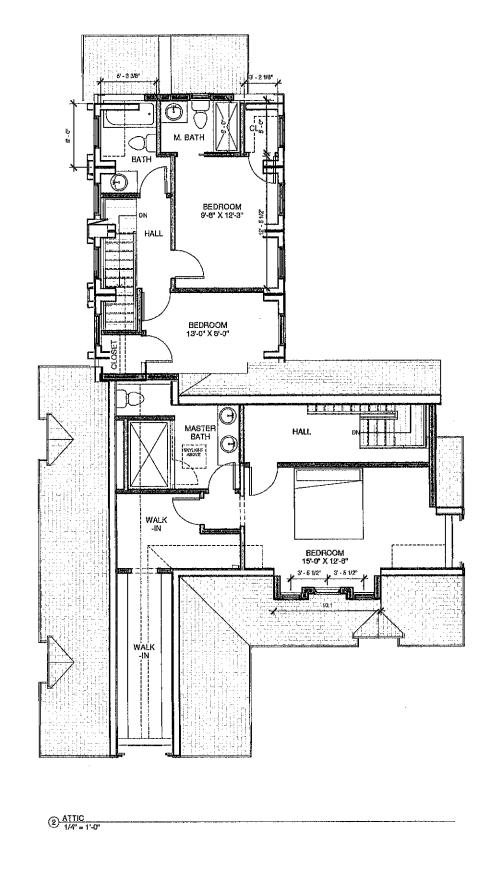

FLOOR PLAN NOTES:

GRAY ELEMENTS INDICATE EXISTING TO REMAIN DARK ELEMENTS INDICATE NEW CONSTRUCTION

MULTIFAMILY RESIDENTIAL RENOVATION 137 SUMMER ST. SOMERVILLE, MA

STEFANOVARCHITECTS

423 WEST BROADWAY, SUITE 404 BOSTON, MA 02127

617.765.0543 INFO@STEFANOVARCH.COM



No.	Description	Date
,		
	1	


-	· ·····	
	I	
	· · · · · · · · · · · · · · · · · · ·	
	 	
		
		L
i		
1		
ı		

PROPOSED FLOOR PLANS

| Project number | 1812.04 |
| Data | 2019-07-05 |
| Drawin by JMB |
| Chocked by DJS |

A1.02

1/4" = 1'-0"

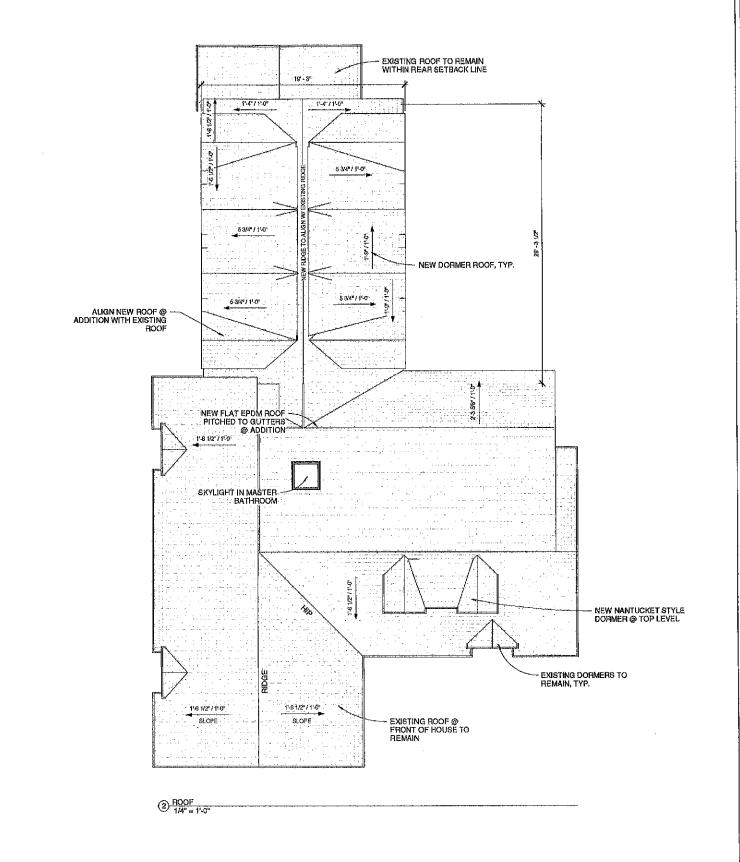

STEFANOVARCHITECTS

423 WEST BROADWAY, SUITE 404 BOSTON, MA 02127 617.765.0543

INFO@STEFANOVARCH.COM



No.	Description	Date
	· · · · · · · · · · · · · · · · · · ·	

	· · · · · · · · · · · · · · · · · · ·	
		ļ
		ļ <u>-</u>
		L
l		L
		L
1		
	l	1
	· · · · · · · · · · · · · · · · · · ·	
		
├──		
	·	<u> </u>

PROPOSED FLOOR PLANS

 Project number
 181204

 Date
 2019-07-05

 Drawn by
 JMB

 Checked by
 DJS

A1.03

1/4" = 1'-0





STEFANOVARCHITECTS

423 WEST BROADWAY, SUITE 404 BOSTON, MA 02127

617.765.0543

INFO@STEFANOVARCH.COM




Vo.	Description	Date


PROPOSED ELEVATIONS

181204 2019-07-05 JMB DJS

A2.01

1/4" = 1'-0"

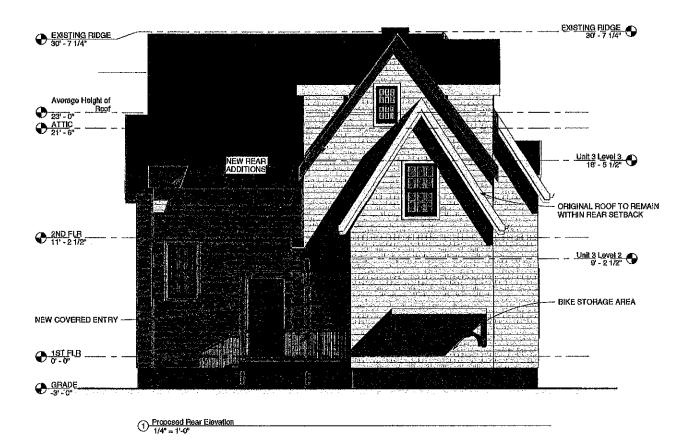

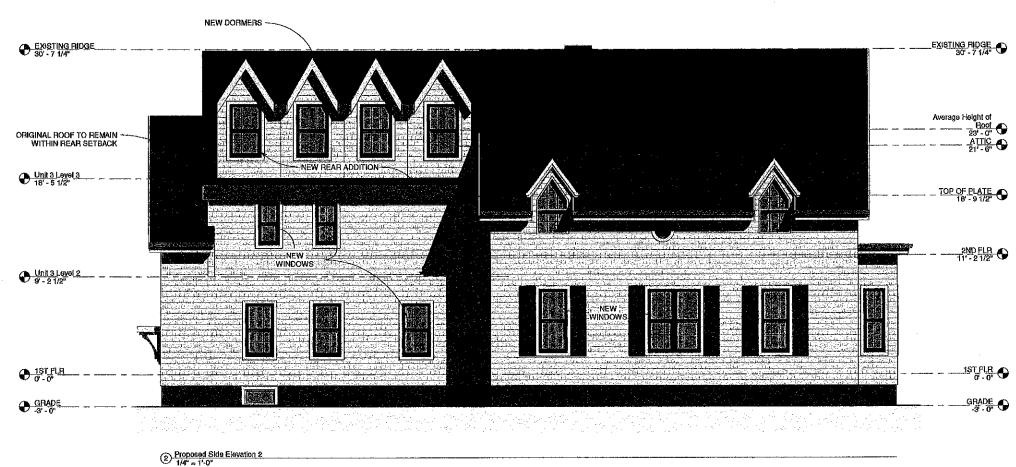

STEFANOYARCHITECTS

423 WEST BROADWAY, SUITE 404 BOSTON, MA 02127

617.765.0543

INFO@STEFANOVARCH.COM



No.	Description	Date
	<u></u>	ļ
	 	<u> </u>
		├
	L	L
		·····

PROPOSED ELEVATIONS

 Project number
 181204


 Date
 2019-07-05

 Orawn by
 JMB

 Checked by
 DUS

A2.02

1/4" = 15

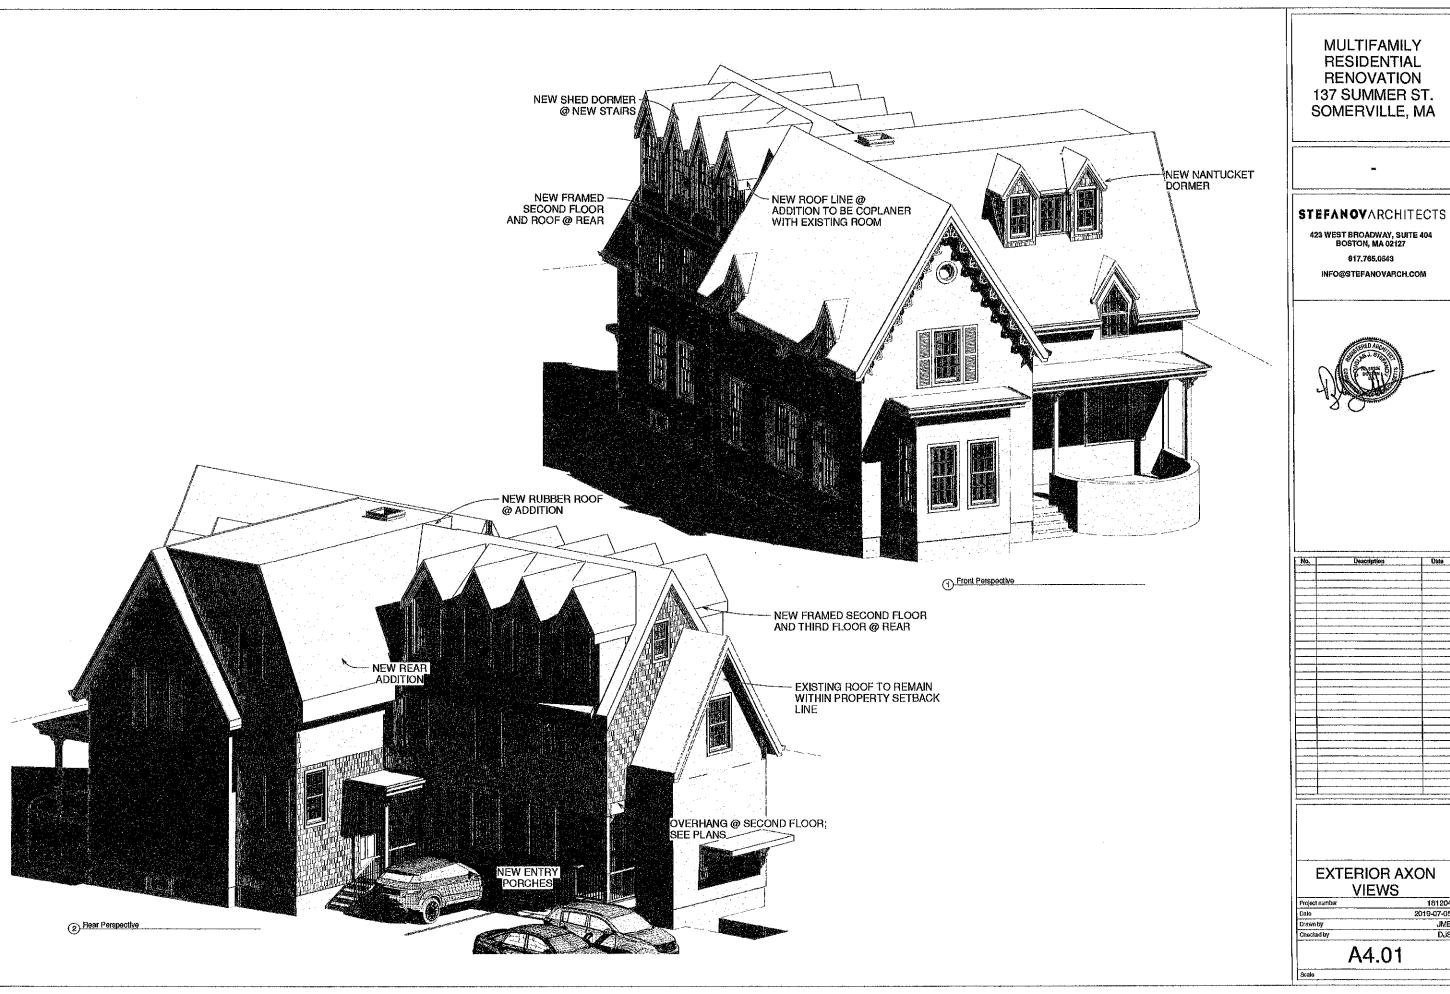

No.	Description	Uate
	 	
		····
	· · · · · · · · · · · · · · · · · · ·	
	·	
	.,	
• • • •	··· ··· · · · · · · · · · · · · · · ·	
•		
		·
	<u> </u>	ļ
		ļ <u></u>
	1	
	1 1 1 1 1 1 1 1 1 1 1 1 1 1 1 1 1 1 1 1	
	<u> </u>	
	·	····

181204 2019-07-05 JMB